# **Demolition Plan**



For Assistance Dogs Australia

At

Lot 23 in DP239091 No. 8 Austin Place, Orchard Hills NSW 2748

Prepared for

Therian Pty Ltd

Ву

Planit Consulting Pty Ltd July 2017

Document Set ID: 7796577 Version: 1, Version Date: 17/08/2017



## 1.0 INTRODUCTION

Planit Consulting Pty Ltd has been commissioned by Therian Pty Ltd on behalf of Assistance Dogs Australia to prepare and submit a demolition works plan for a development application for the construction of the Assistance Dogs Australia National Training Facility at the subject site.

## 2.0 DESCRIPTION OF WHAT IS TO BE DEMOLISHED

The proposal includes demolition of walls including internal and external for buildings A, B and D. Entire demolition of the existing dwelling C is proposed to facilitate a new storage facility.

Demolition works are proposed to facilitate the proposal and is summarised in the below table:

Building 'A'	Demolition of walls including internal
Building 'B'	Demolition of walls including internal and partial roof removal.
Building 'C'	Existing building to be completely demolished
Building 'D'	Demolition of walls including internal

The demolition of structures has been identified in Attachment A- Site Plan.

## 3.0 WORK PLAN

Clause 13 of the Local Government (Approvals) Regulation 1993 requires Council to take into consideration the provisions of Australian Standard AS2601-2001. Clause 1.7.3 within this standard identifies a requirement to submit a work plan before any consent is issued.

Details specific to this work plan are provided as follows:-

a. The location of the site on which the structure to be demolished stands.

Lot 23 in DP239091 being No. 8 Austin Place, Orchard Hills NSW. (See Attachment A- Site Plan).

b. The overall height of the structure above ground level and the least distance from the structure to each site boundary.

No buildings exceed two storeys in height. Buildings A, B and C are currently single storey in height whilst building D is two storeys.

The following table identifies the height of structures to be demolished and distance from the structure to each site boundary.

Building	Α	В	С	D
Overall Height	7.2	7.7	7.4	8.8
(m)				
Note: measured at				
their highest point to				
the ground level.				
Distance to Boundary				
North (m)	220	193	182	166
East (m)	9.2	41	26	4.8
South (m)	11	30	40	67
West (m)	55	22	47	62

PO Box 1623 Kingscliff NSW 2487

Phone: 02 66745001 Fax: 02 66745003

info@planitconsulting.com.au

Document Set ID: 7796577 Version: 1, Version Date: 17/08/2017



A brief description of the type of building (occupancy class) its structural support system and the C. principle materials of its construction.

The historic use of the site includes consent in 1978 (file number 37/78), 1982 (D2505DA.1) and 1983 (D2505DA.2) for the construction of a staged development involving the erection of single storey building for housing for mentally handicapped adults.

The description relative to each dwelling is specified below:

Building	Α	В	С	D
Class of Building as defined under	Class 3	Class 3	Class 6	Class 3
NCC.				
Structural	Slab on ground	Slab on ground	Slab on ground	Slab on ground/
Support/				timber post
Description				
Materials of	Brick veneer,	Brick veneer,	Brick veneer,	Brick veneer,
Construction	concrete slab,	concrete slab,	concrete slab,	concrete slab,
	timber, roof tiles,	timber, roof tiles,	timber, roof tiles,	timber, roof tiles,
	glazing and	glazing and	glazing and	glazing and
	aluminium.	aluminium.	aluminium.	aluminium.

d. Description of the method of the demolition proposed to be used and the number and type of major items of equipment proposed for implementing those methods.

Demolition methods of the buildings on site will be undertaken using either one (1) of the following methods for each building:

## For demolition of Buildings A, B & D

- 1. Remove specified windows, doors and internal walls;
- 2. Dismantle selected all plumbing, electrical wiring and wall framing;
- 3. Remove specified external walls;
- 4. Partial roof removal (building B only); and
- 5. Clean up site.

## For demolition of Building C

- 1. Remove roofing and roofing frame;
- 2. Remove all windows, doors and internal walls;
- 3. Dismantle all plumbing, electrical wiring and wall framing;
- 4. Remove all external walls;
- 5. Remove floor, piers and concrete slabs; and
- 6. Clean up site.
- A description of the methods proposed for handling and disposing of demolished material and in e. particular hazardous material.

All materials will be handled treated and disposed of in accordance with the Workcover Guidelines and the provisions of the Australian Standards. Material will be recycled and disposed of at the Patons Lane Resource Recovery Centre where possible.

f. A description of the proposed sequence of carrying out the demolition work and an estimate of the time, in days, it is likely to take to complete all or each of the stages of the work.

Estimated time to demolish each building is as follows:

PO Box 1623 Kingscliff NSW 2487

Phone: 02 66745001 Fax: 02 66745003

info@planitconsulting.com.au



## Building A:

- Removal of specified structures including windows, doors, internal walls, plumbing, electrical wiring and external walls is two (2) days.

## Building B:

 Removal of specified structures including windows, doors, internal walls, plumbing, electrical wiring and external walls and part of room is two (2) days.

## Building C:

- Removal of all structures is three (3) days.

### Building D:

- Removal of specified structures including windows, doors, internal walls, plumbing, electrical wiring and external walls is two (2) days.

### Details of the proposed protective measures, including overhead protection and scaffolding required g. by clause/s 1.5 & 1.7.

A perimeter security fence will be erected for each dwelling during the relevant demolition period and will remain until such time that the site is deemed safe.

#### h. **Dimensions of the Demolition Exclusion Zone**

All demolition work will be carried out on-site and there will be no disruption to the surrounding area. Safety fencing around the worksite is to be erected in accordance with Workcover requirements. Safety signage is to be attached to the fencing advising the site is a demolition site, warning non-authorised people to stay out.

i. Any other plans, illustrations, or written documents as may be necessary to clearly define or substantiate the proposals made under items d. to g.

N/A.

#### j. **Traffic Management Plan**

Loading and removal of materials and machinery will occur onsite with ample room available. Disruptions will be kept to a minimal as heavy vehicles will only arrive at the site when material is ready to be loaded.

#### k. **Environmental Management Plan**

The demolition works are of a relatively minor scale. A formal Environmental Management Plan is not considered to be required.

#### I. Occupational Health and Safety

Appropriate safety equipment is to be worn at all times by demolition workers including safety boots, helmets, sun protection clothing and the like. The requirements under AS4801 will be complied with at all times. Council are invited to impose appropriate conditions in this regard.

#### m. What materials are proposed to be reused, used as second hand material.

Demolition of the majority of the buildings are for refurbishment, material that is proposed to be removed is to be reused where possible on site, if deemed appropriate by super intendant. Other material deemed not suitable for reuse on the site will be recycled where appropriate at Patons Lane Resource Recovery Centre.

PO Box 1623 Kingscliff NSW 2487

Phone: 02 66745001 Fax: 02 66745003

info@planitconsulting.com.au



#### What materials are proposed to be recycled or reprocessed. n.

Where possible external walls for buildings A, B and D, ground floor, roofing and any ancillary components of the dwelling will be used with the dwellings to be refurbished. Materials demolished as part of building C will either be reused on site for the site proposal and/or recycled where appropriate at Patons Lane Resource Recovery Centre.

#### What materials are proposed to be sorted on site prior to disposal. 0.

All materials will be sorted on site before disposal.

#### p. The location of the proposed disposal site.

Patons Lane Resource Recovery Centre is the nominated disposal site.

#### q. Chemical treatment under slab

It is of the opinion that no chemical treatment under the existing slab has occurred or remains for buildings A, B, C and D.

info@planitconsulting.com.au



## Attachment A – Site Plan


## NATIONAL TRAINING CENTRE REDEVELOPMENT

8 AUSTIN PLACE, ORCHARD HILLS, NSW 2748


## ARCHITECTURAL DRAWING LIST


DRAWING No	DRAWING NAME
DA00	ARCHITECTURAL DRAWING LIST
DA01	SITE PLAN - OVERALL
DA02	SITE PLAN - PROPOSED
DA03	BUILDING 'A' - PROPOSED DESIGN
DA04	BUILDING 'B' - PROPOSED DESIGN
DA05	BUILDING 'C' - PROPOSED DESIGN
DA06	BUILDING 'C' - PROPOSED DESIGN
DA07	BUILDING 'D' - PROPOSED FLOOR PLAN
DA08	BUILDING 'D' - ELEVATIONS
DA09	BUILDING 'E' - PROPOSED FLOOR PLAN
DA10	BUILDING 'E' - ELEVATIONS
DA11	BUILDING 'F' - PROPOSED DESIGN



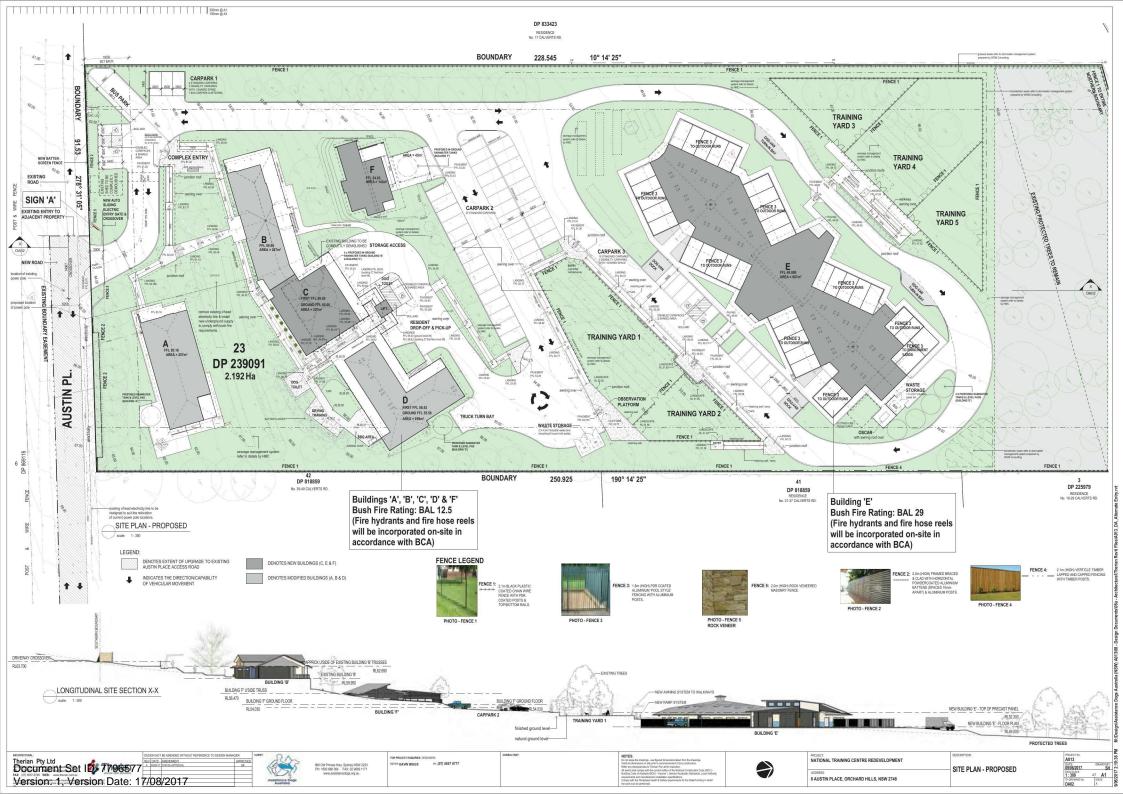



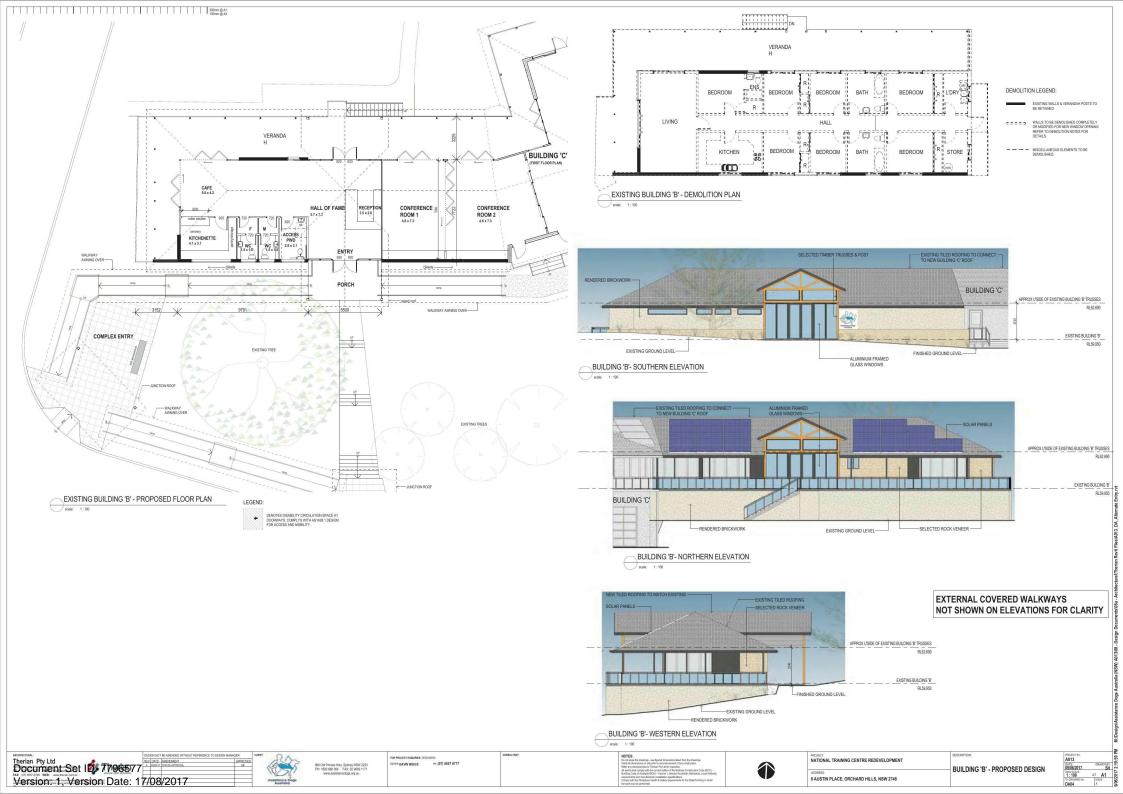


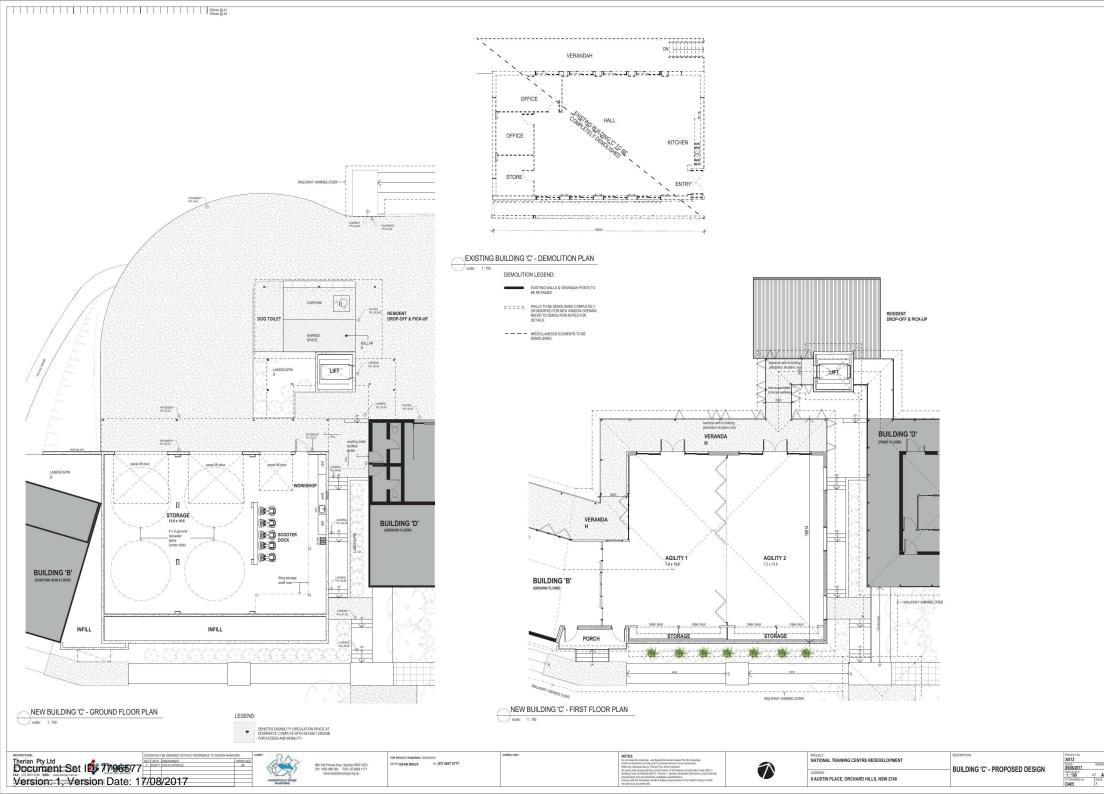

oriene Dans Anabe E. (MPM) Abdelon Dans Dansseichen Antischen Efferie Drift Föreich Ab



BUILDING 'C'- EASTERN ELEVATION
scale: 1:100

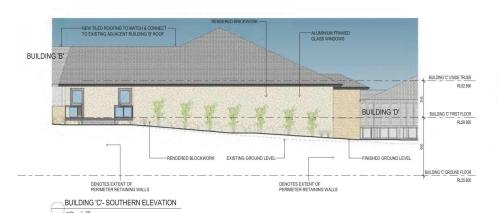

BLFOLING PLANTATION SHUTTERS

BLFOLING CUSCE TRASS
RLESSO

SHEETING & PLANTATION SHUTTERS

BUILDING 'C'- WESTERN ELEVATION

RETAINING WALL

EXISTING GROUND LEVEL

FINSHED GROUND LEVEL

FINSHED GROUND LEVEL

EXTERNAL COVERED WALKWAYS
NOT SHOWN ON ELEVATIONS FOR CLARITY

Description Type Ltd Document Set I 7796577

(JED)

996 Old Princes Hwy, Sydney NSW 22 PH: 1800 688 364 FAX: 02 9699 11 www.assistancedogs.org.au FOR PROJECT ENQUIRES: DESIGNERS
REFER: GAVIN BIGGS PH: (07) 5657 6777

NOTES:
Don't sixual his dissalings: use figured dimensions below his disseller, but for dissalings with produced and dimensions on sixual prior to commencement of any understood.
Heller any disseppoints on themson Prus Lamensation.
All works shall comply with the current edition of the National Constitution Clode (NOC)—buildings Closel of Lamensation (Cloth States). Authority requirements and manufacture in installation specifications. Under Authority requirements and manufacture in installation specifications.

MADDRAIL TRAINING CENTRE REDEVELOPMENT

ACCRESS

8 AUSTIN PLACE, ORCHARD HILLS, NSW 2748


PROJECT No.
A013


DATE 9906/2017
9906/2017
1:100

AT A1

TH DRAWING No.
BOSUE
A



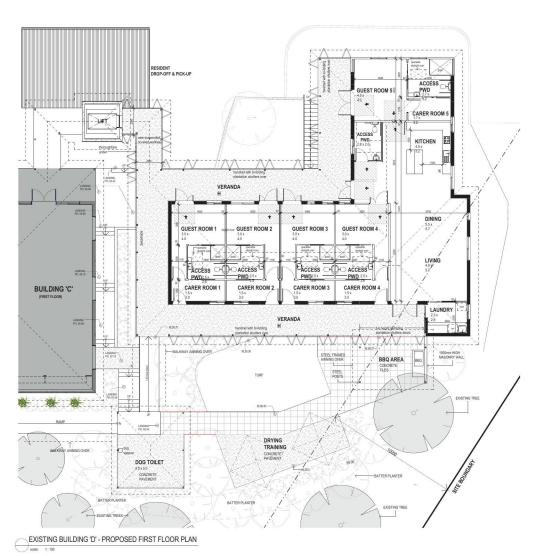

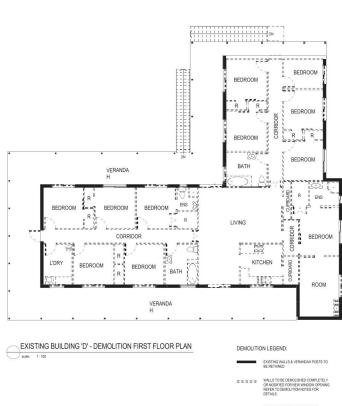

MISCELLANEOUS ELEMENTS TO BE DEMOUSHED.



EXISTING BUILDING 'D' - PROPOSED GROUND FLOOR PLAN

Therian Pty Ltd Document Set 15 7796577 Version: 1, Version Date: 17/08/2017

REFER GAVIN BIGGS

NATIONAL TRAINING CENTRE REDEVELOPMENT BUILDING 'D' - PROPOSED FLOOR PLAN DATE 09:06/2017 8 AUSTIN PLACE, ORCHARD HILLS, NSW 2748

PH: (07) 5657 6777





BUILDING 'D'- SOUTHERN ELEVATION

scale: 1: 100

EXTERNAL COVERED WALKWAYS
NOT SHOWN ON ELEVATIONS FOR CLARITY



BUILDING 'D'- WESTERN ELEVATION

Therian Pty Ltd Document Set I 7796577

CLENT:

996 Old Princis Hwy, Sydney NSW 22 PH: 1800 688 364 FAX: 02 9699 11' www.assistancedogs.org.au FOR PROJECT ENGUINES: DESIGNERS
PEFER: GAVIN BIGGS PH. (07) 5657 6777

NOTES:
Durat cause for discharge, sea figured dimensions taken from the ordering.
Durat cause for discharge, sea figured dimensions taken from the ordering
Filled are glossipproted by the Filled fill of the residual.
All who ship cause from the filled fill of the filled filled filled fill of the filled fill of the filled fill of the filled filled filled filled filled filled fill of the filled fille


PROSECT
NATIONAL TRAINING CENTRE REDEVELOPMENT

BUILDING 'D' - ELEVATIONS

8 AUSTIN PLACE, ORCHARD HILLS, NSW 2748

PROJECT No.
AD13
DATE:
09/06/2017
DRIAWN 1
09/06/2017
DRIAWN 5
1:100
AT A1
THO DATE
DA08
A

sietanoo Door Australia MCMA A44100. Dooron Dooronoonte 1100 ... Arabiika

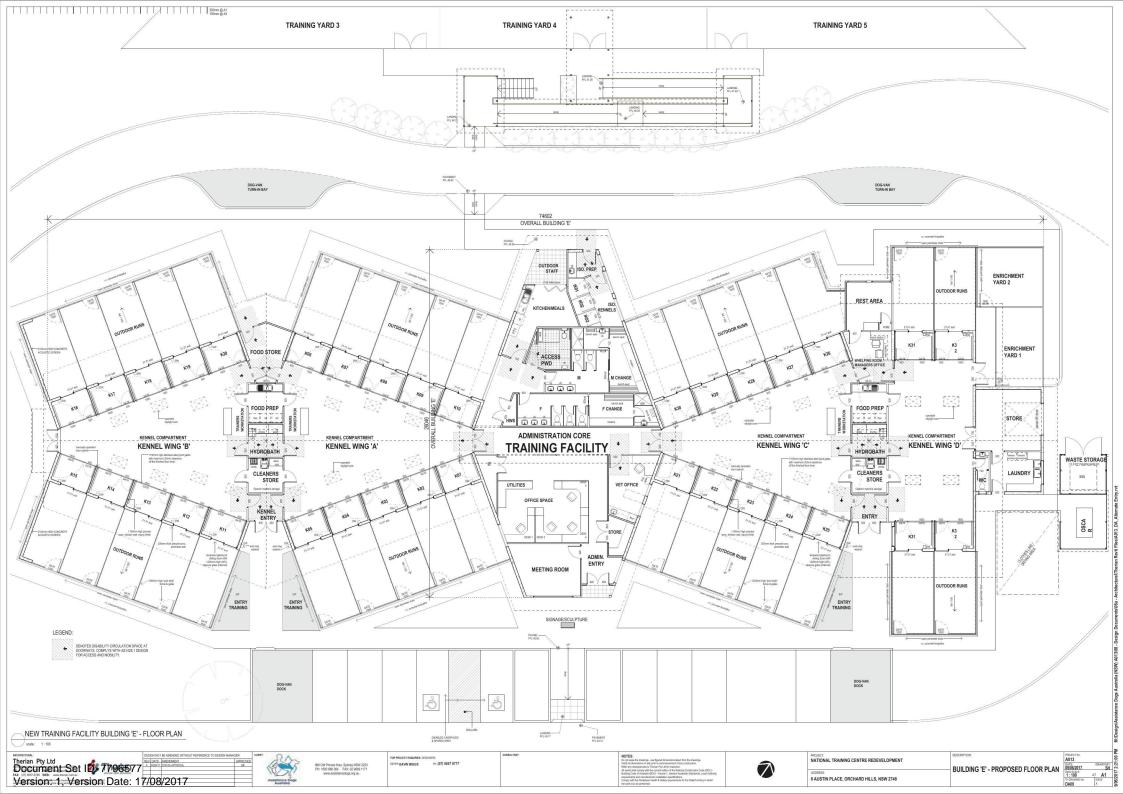





EXTERNAL COVERED WALKWAYS NOT SHOWN ON ELEVATIONS FOR CLARITY

Therian Pty Ltd Document Set ID: 7796577

CLENT:

996 Old Princes Hwy, Sydney NSW 2233 PH: 1800 688 364 FAX: 02 9699 1171 FOR PROJECT ENGUINES: DESIGNERS
REFER: GAVIN BIGGS PH: (07) 5657 6777

NOTES:
Do not suit the drawings - see figured dissessions taken from the drawings.
Verify all dimensions on sits prior to commencement of any construction.
Rate any dissepancies to Testina Ply Lift for resolution.
All words and complywhich the contract clother of the National Construction Code (NOC)—
Buildings Code of Avairation (CPA)—Indiant 1, relevant including Standards, code and Avairation (CPA)—Indiants 1, relevant includings Standards, Code (NOC)—
Buildings Code of Avairation (CPA)—Indiants 1, relevant includings Standards, Code (NOC)—
Buildings Code of Avairation (CPA)—Indiants 1, relevant includings Standards, Code (NOC)—
Buildings Code of Avairation (CPA)—Indiants 1, relevant includings Standards, CPA
Buildings Code of Avairation (CPA)—Indiants 1, relevant includings Standards, CPA
Buildings Code of Avairation (CPA)—Indiants 1, relevant includings Standards, CPA
Buildings Code of Avairation (CPA)—Indiants 1, relevant includings Standards, CPA
Buildings Code of Avairation (CPA)—Indiants 1, relevant includings Standards, CPA
Buildings Code of Avairation (CPA)—Indiants 1, relevant includings Standards, CPA
Buildings Code of Avairation (CPA)—Indiants 1, relevant includings Standards, CPA
Buildings CPA
Buildin

PROJECT
MATIONAL TRAINING CENTRE REDEVELOPMENT

ACCRESS

& AUSTIN PLACE, ORCHARD HILLS, NSW 2748